

STEEL POST

WIRE FABRIC

FILTER FABRIC

FABRIC

SKIRT AS

DIRECTED

ENGINEER

removed and recycled.

MIN. 12-1/2 GA.

1. FENCE FABRIC SHALL BE A MIN. OF 32" IN WIDTH AND SHALL HAVE A MIN. OF SIX LINE WIRES WITH 12" STAY

2. FABRIC SHALL BE FOR EROSION CONTROL AND MIN. OF 36" IN WIDTH. FABRIC SHALL BE FASTENED ADEQUATELY TO THE WIRE FABRIC AS DIRECTED BY THE

3. STEEL POST SHALL BE 5'-0" IN HEIGHT AND BE OF THE SELF-FASTENER STEEL ANGLE TYPE.

TEMPORARY SILT FENCE

Cap flush with

4 to 6 in. diameter perforated pipe

Insert 4 to 6 in.

PERMEABLE CONCRETE

MONITORING WELL

into soil subgrade


pavement

/INTERMEDIATE WIRES

VARIES (6'-8' MIN.)

NOTES:

AS DIR. BY ENG.

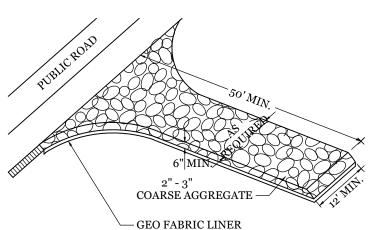

NOTE: CONSTRUCTION ENTRANCE TO BE 12' OR ENTIRE WIDTH OF

TEMPORARY GRAVEL CONSTRUCTION ENTRANCE

SITE WORK NOTES:

Mountains - Aug. 15-Dec. 15

MAINTENANCE:

following erosion or other damage.

Coastal Plain and Piedmont - Aug. 15-Dec. 30

limestone and 750 lb/acre 10-10-10 fertilizer.

apply 4,000 lb/acre straw. anchor straw by tacking with asphalt, netting, or a

mulch anchoring tool. A disk with blades set nearly straight can be used as a mulch

Refertilize if growth is not fully adequate. reseed, refertilize and mulch immediately

1. THE CONTRACTOR SHALL VISIT THE SITE AND BECOME FAMILIAR WITH EXISTING CONDITIONS BOTH ON AND ADJACENT TO THE SITE.

THE CONTRACTOR SHALL FURNISH SUITABLE BORROW MATERIAL FROM AN OFF-SITE PROPERLY PERMITTED FACILITY AS REQUIRED.

- CLEARING: CONTRACTOR SHALL REMOVE ALL TREES AND VEGETATION WITHIN LIMITS OF CONSTRUCTION UNLESS OTHERWISE DESIGNATED TO REMAIN. GRUBBING AND STRIPPING: CONTRACTOR SHALL RAKE AND REMOVE ROOTS, STUMPS, VEGETATION, DEBRIS, EXISTING STRUCTURES ABOVE AND BELOW GRADE, ORGANIC MATERIAL OR ANY OTHER UNSUITABLE

- DISPOSAL: CLEARED, GRUBBED, STRIPPED OR OTHER WASTE MATERIAL SHALL BE REMOVED FROM SITE AND DISPOSED OF IN A PROPERLY PERMITTED FACILITY. FILL AND COMPACTION SHOULD COMPLY WITH GEOTECHNICAL RECOMMENDATIONS.
- THE CONTRACTOR SHALL NOTE THAT THE GRADING PLAN MAY NOT REPRESENT A BALANCED EARTHWORK CONDITION. THE CONTRACTOR SHALL BE RESPONSIBLE FOR CUT AND FILL QUANTITIES AND COMPLETE INSTALLATION TO SPECIFIED GRADES.
- INFORMATION CONCERNING UNDERGROUND UTILITIES WAS OBTAINED FROM AVAILABLE RECORDS. IT SHALL BE THE RESPONSIBILITY OF THE CONTRACTOR TO DETERMINE THE EXACT ELEVATIONS AND LOCATIONS OF ALL EXISTING UTILITIES AT ALL CROSSINGS PRIOR TO COMMENCING TRENCH EXCAVATION. IF ACTUAL CLEARANCES ARE LESS THAN INDICATED ON PLAN. THE CONTRACTOR SHALL CONTACT THE DESIGN
- THE CONTRACTOR IS RESPONSIBLE FOR THE LOCATION AND PROTECTION OF ALL EXISTING UTILITIES DURING CONSTRUCTION. BEFORE COMMENCING ANY EXCAVATIONS IN OR ALONG ROADWAYS OR
- 12. THE CONTRACTOR SHALL BE RESPONSIBLE TO COORDINATE DISCONNECTION/ RECONNECTION AND/OR THE RELOCATION OF ALL EXISTING UTILITIES WITH APPROPRIATE PERSONNEL
- 13. CONTRACTOR SHALL ADJUST ALL MANHOLES, VALVE & CURB BOXES TO FINAL GRADE UPON COMPLETION OF ALL CONSTRUCTION, ANY BOXES DAMAGED OR OTHERWISE DISTURBED BY THE CONTRACTOR SHALL BE
- 14. EXISTING SURVEY DATA PROVIDED BY GEOINNOVATION, PC. 15. THE CONTRACTOR SHALL FIELD VERIFY ALL DIMENSIONS AT THE SITE. FURTHERMORE THE CONTRACTOR SHALL REPORT ALL DISCREPANCIES OR QUESTIONS TO THE ENGINEER PRIOR TO INSTALLATION.
- 16. THE CONTRACTOR SHALL PROVIDE ANY AND ALL LAYOUT REQUIRED TO CONSTRUCT HIS WORK UNLESS OTHERWISE DIRECTED BY OWNER.
- 18. ALL BACKFILL FROM UTILITY INSTALLATION MUST BE COMPACTED OR AMENDED TO PROVIDE TRAFFIC BEARING CAPACITY. GEOTECHNICAL ENGINEER TO BE CONSULTED AT CONTRACTORS COST AS NECESSARY. 19. ALL AREAS SHALL BE GRADED FOR POSITIVE DRAINAGE. CONTRACTOR SHALL REPORT ANY DISCREPANCIES TO THE ENGINEER PRIOR TO INSTALLATION. ALL AREAS SHALL BE SLOPED TO DRAIN AWAY FROM
- 20. CONCRETE FOR WALKS, CURBS AND DRIVES SHALL HAVE A MINIMUM COMPRESSIVE STRENGTH OF 3000 PSI @ 28 DAYS AIR ENTRAINED.
- 21. FIELD TESTING SHALL BE DONE BY AN INDEPENDENT TESTING LABORATORY PAID FOR BY THE OWNER. FURTHER TESTING REQUIRED DUE TO A FAILED TEST WILL BE PAID FOR BY THE CONTRACTOR.

NORTH CAROLINA TEMPORARY GRASSING DETAIL		NORTH CAROLINA PERMANENT GRASSING DETAIL	
SEEDING MIXTURE SPECIES	APPLICATION RATE	SEEDING MIXTURE SPECIES	APPLICATION RATE
LATE WINTER & EARLY SPRING: Rye (grain) Annual Iespedeza (Kobe in Piedmont	100 (lb/acre)	FALL & WINTER: Tall Fescue (blend of two or three improved varieties)	200 (lb/acre)
and Coastal Plain, Korean in Mountains) Omit annual Iespedeza when duration	50 (lb/acre)	Rye (grain)	25 (lb/acre)
of temporary cover is not to extend beyond June SUMMER: German Millet		SPRING & SUMMER: Pensacola Bahiagrass Sericea Lespedeza Common Bermudagrass	50 (lb/acre) 30 (lb/acre) 10 (lb/acre)
German Milet In the Piedmont and Mountains, a small-stemmed sundangrass may be substituted at a rate of 50 (lb/acre)	40 (lb/acre)	German Millet Tall Fescue	10 (lb/acre) 10 (lb/acre) 50 (lb/acre)
FALL: Rye (grain)	120 (lb/acre)	FALL & WINTER: January - April August - December	
SEEDING DATES LATE WINTER & EARLY SPRING: Mountains - Above 2500 ft: Feb. 15-May 15 Piedmont - Jan. 1-May 1		SOIL AMENDMENTS: Apply lime and fertilizer according to soil tests, or apply 3.000-5,000 lb/acre ground agricultural limestone (use the lower rate on sandy soils) and 1,000 lb/acre 10-10-10 fertilizer.	
Coastal Plain - Dec. 1-Apr. 15 SUMMER: Mountains - May 15-Aug. 15 Piedmont - May 1-Aug. 15 Coastal Plain - Apr. 15-Aug. 15		MAINTENANCE: Fertilize according to soil tests or apply 40 lb/acre nitrogen in January or february 40 lb in September and 40 lb in November, from a 12-4-8, 16-4-8, or similar turf fertilizer. Avoid fertilizer applications during warm weather, as this increases star losses to disease. Reseed, fertilize, and mulch damaged areas immediately. mow to a height of 2.5-3.5 inches as needed.	

April 1 - July 15

SPRING & SUMMER:

SOIL AMENDMENTS: Apply lime and fertilizer according to soil tests, or apply 3,000 lb/acre ground agriculture limestone and 500 lb/acre 10-10-10 fertilizer

MAINTENANCE:
Refertilize the following april with 50 lb/acre nitrogen. Repeat as growth requires. may be moved only once a year. Where a neat appearance is desired, omit sericea and mow as often as needed.

apply 4,000 lb/acre straw. anchor straw by tacking with asphalt, netting, or a mulch anchoring tool. A disk with blades set nearly straight can be used as a mulch

SYMBOL	GROUND STABILIZATION CRITERIA			
	SITE AREA DESCRIPTION	STABILIZATION TIMEFRAME	STABILIZATION TIMEFRAME EXCEPTIONS	
	* Perimeter dikes, ditches and slopes	7 Days	None	
	* High Quality Water (HQW) Zones	7 Days	None	
	* Slopes Steeper than 3:1	7 Days	If slopes are 10' or less in length and are not steeper than 2:1, 14 days are allowed	
\(\psi\) \(\	* Slopes 3:1 or flatter	14 Days	7-days for slopes greater than 50 ft. in length	
\(\psi\) \(\	* All other areas with slopes flatter than 4:1	14 Days	None (except for perimeters & HQW Zones)	

BUILDING WASTE HANDLING:

- NO PAINT OR LIQUID WASTES IN STREAM OR STORM DRAINS DEDICATED AREAS FOR DEMOLITION, CONSTRUCTION AND OTHER WASTES MUST BE LOCATED 50' FROM STORM DRAINS AND STREAMS UNLESS NO REASONABLE ALTERNATIVES ARE AVAILABLE.
- EARTHEN MATERIAL STOCKPILES MUST BE LOCATED 50' FROM STORM DRAINS AND STREAMS UNLESS NO REASONABLE ALTERNATIVES ARE AVAILABLE. - CONCRETE MATERIALS MUST BE CONTROLLED TO AVOID CONTACT WITH SURFACE WATERS, WETLANDS, OR BUFFERS, INSPECTIONS:
- SAME WEEKLY REQUIREMENTS - SAME RAIN GAUGE & INSPECTIONS AFTER 0.50" RAIN EVENT. INSPECTIONS ARE ONLY REQUIRED DURING "NORMAL BUSINESS HOURS" INSPECTION REPORTS MUST BE AVAILABLE ON-SITE DURING BUSINESS HOURS
- UNLESS A SITE-SPECIFIC EXEMPTION IS APPROVED. - RECORDS MUST BE KEPT FOR 3 YEARS AND AVAILABLE UPON REQUEST. ELECTRONICALLY AVAILABLE RECORDS MAY BE SUBSTITUTED UNDER CERTAIN

SEDIMENT BASINS: - OUTLET STRUCTURES MUST BE WITHDRAWN FROM BASIN SURFACES UNLESS DRAINAGE AREA IS LESS THAN 1 ACRE. - USE ONLY DWQ APPROVED FLOCCULANTS.


Top View


Side View

WAVE STYLE BIKE RACK DETAIL

5 BIKE RACK

NTS

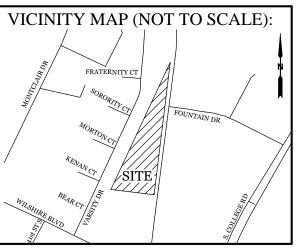

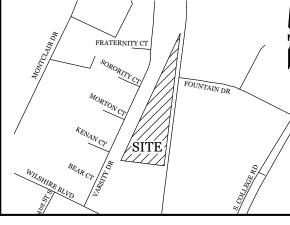

REVISIONS



DETAILS


MBL SE KERR

CLIENT INFORMATION: Wilmington Brewing Company, LLC 824 S. Kerr Ave.

RAWN:	JAE	SHEET SIZE:	24x36
HECKED:	CDC	DATE:	8/16/2019
PPROVED:	CDC	SCALE:	NTC


DRAWING NUMBER:

C-2

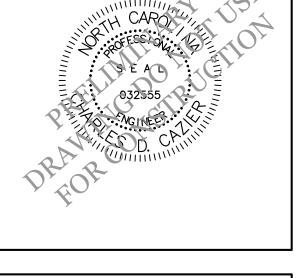



Wilmington, NC 28403 Ph. 910-392-3315

PROJECT NUMBER: 2018-035

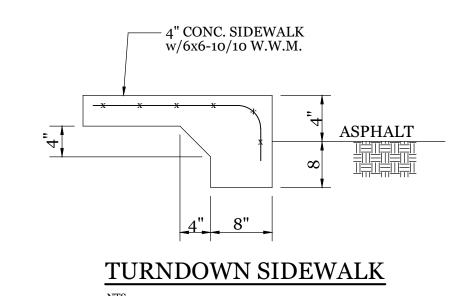

SECTION A - A

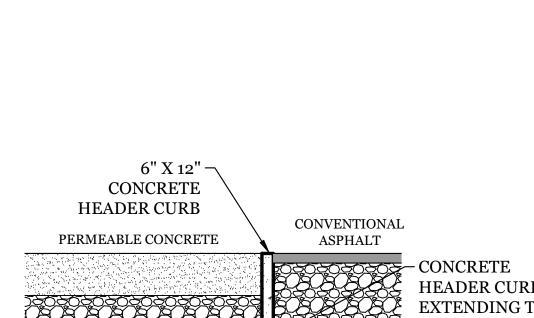

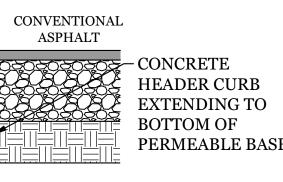


SEE PLAN

NOTES:

1. CLASS "B" RIP RAP TO BE USED FOR ALL ENERGY DISSIPATOR AREAS.

ENERGY DISSIPATOR



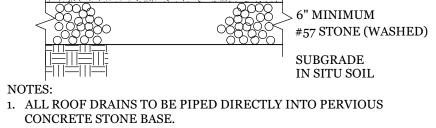

6" PERVIOUS

CONCRETE

WIDTH x LENGTH x HEIGHT 9" x 7'-0" x 4"



PLAN VIEW

- 7/8"Ø HOLES—


FRONT VIEW


1. CONTRACTOR SHALL INSTALL PER CITY OF WILMINGTON TECHNICAL STANDARD PER SD 15-13

WHEEL STOP DETAIL

2. CONTRACTOR SHALL INSTALL WHEEL STOP 2.5' FROM SIDEWALK.

NTS

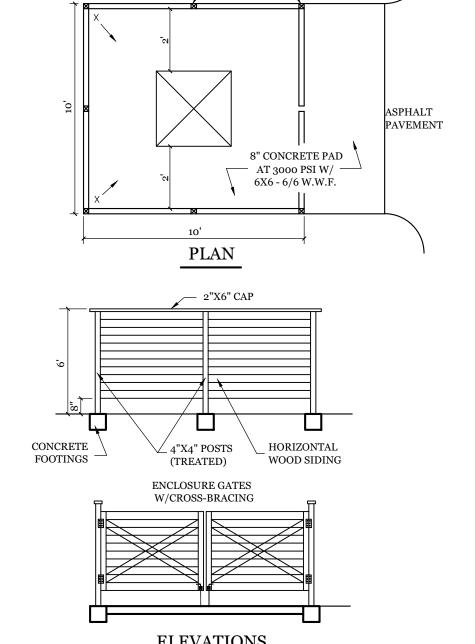


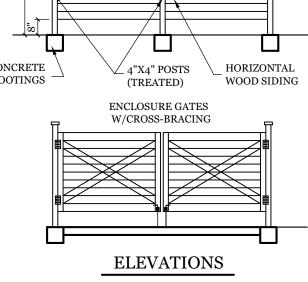

DUMPSTER PAD & ENCLOSURE DETAIL

Public Services • Engineering Division APPROVED DRAINAGE PLAN


Approved Construction Plan

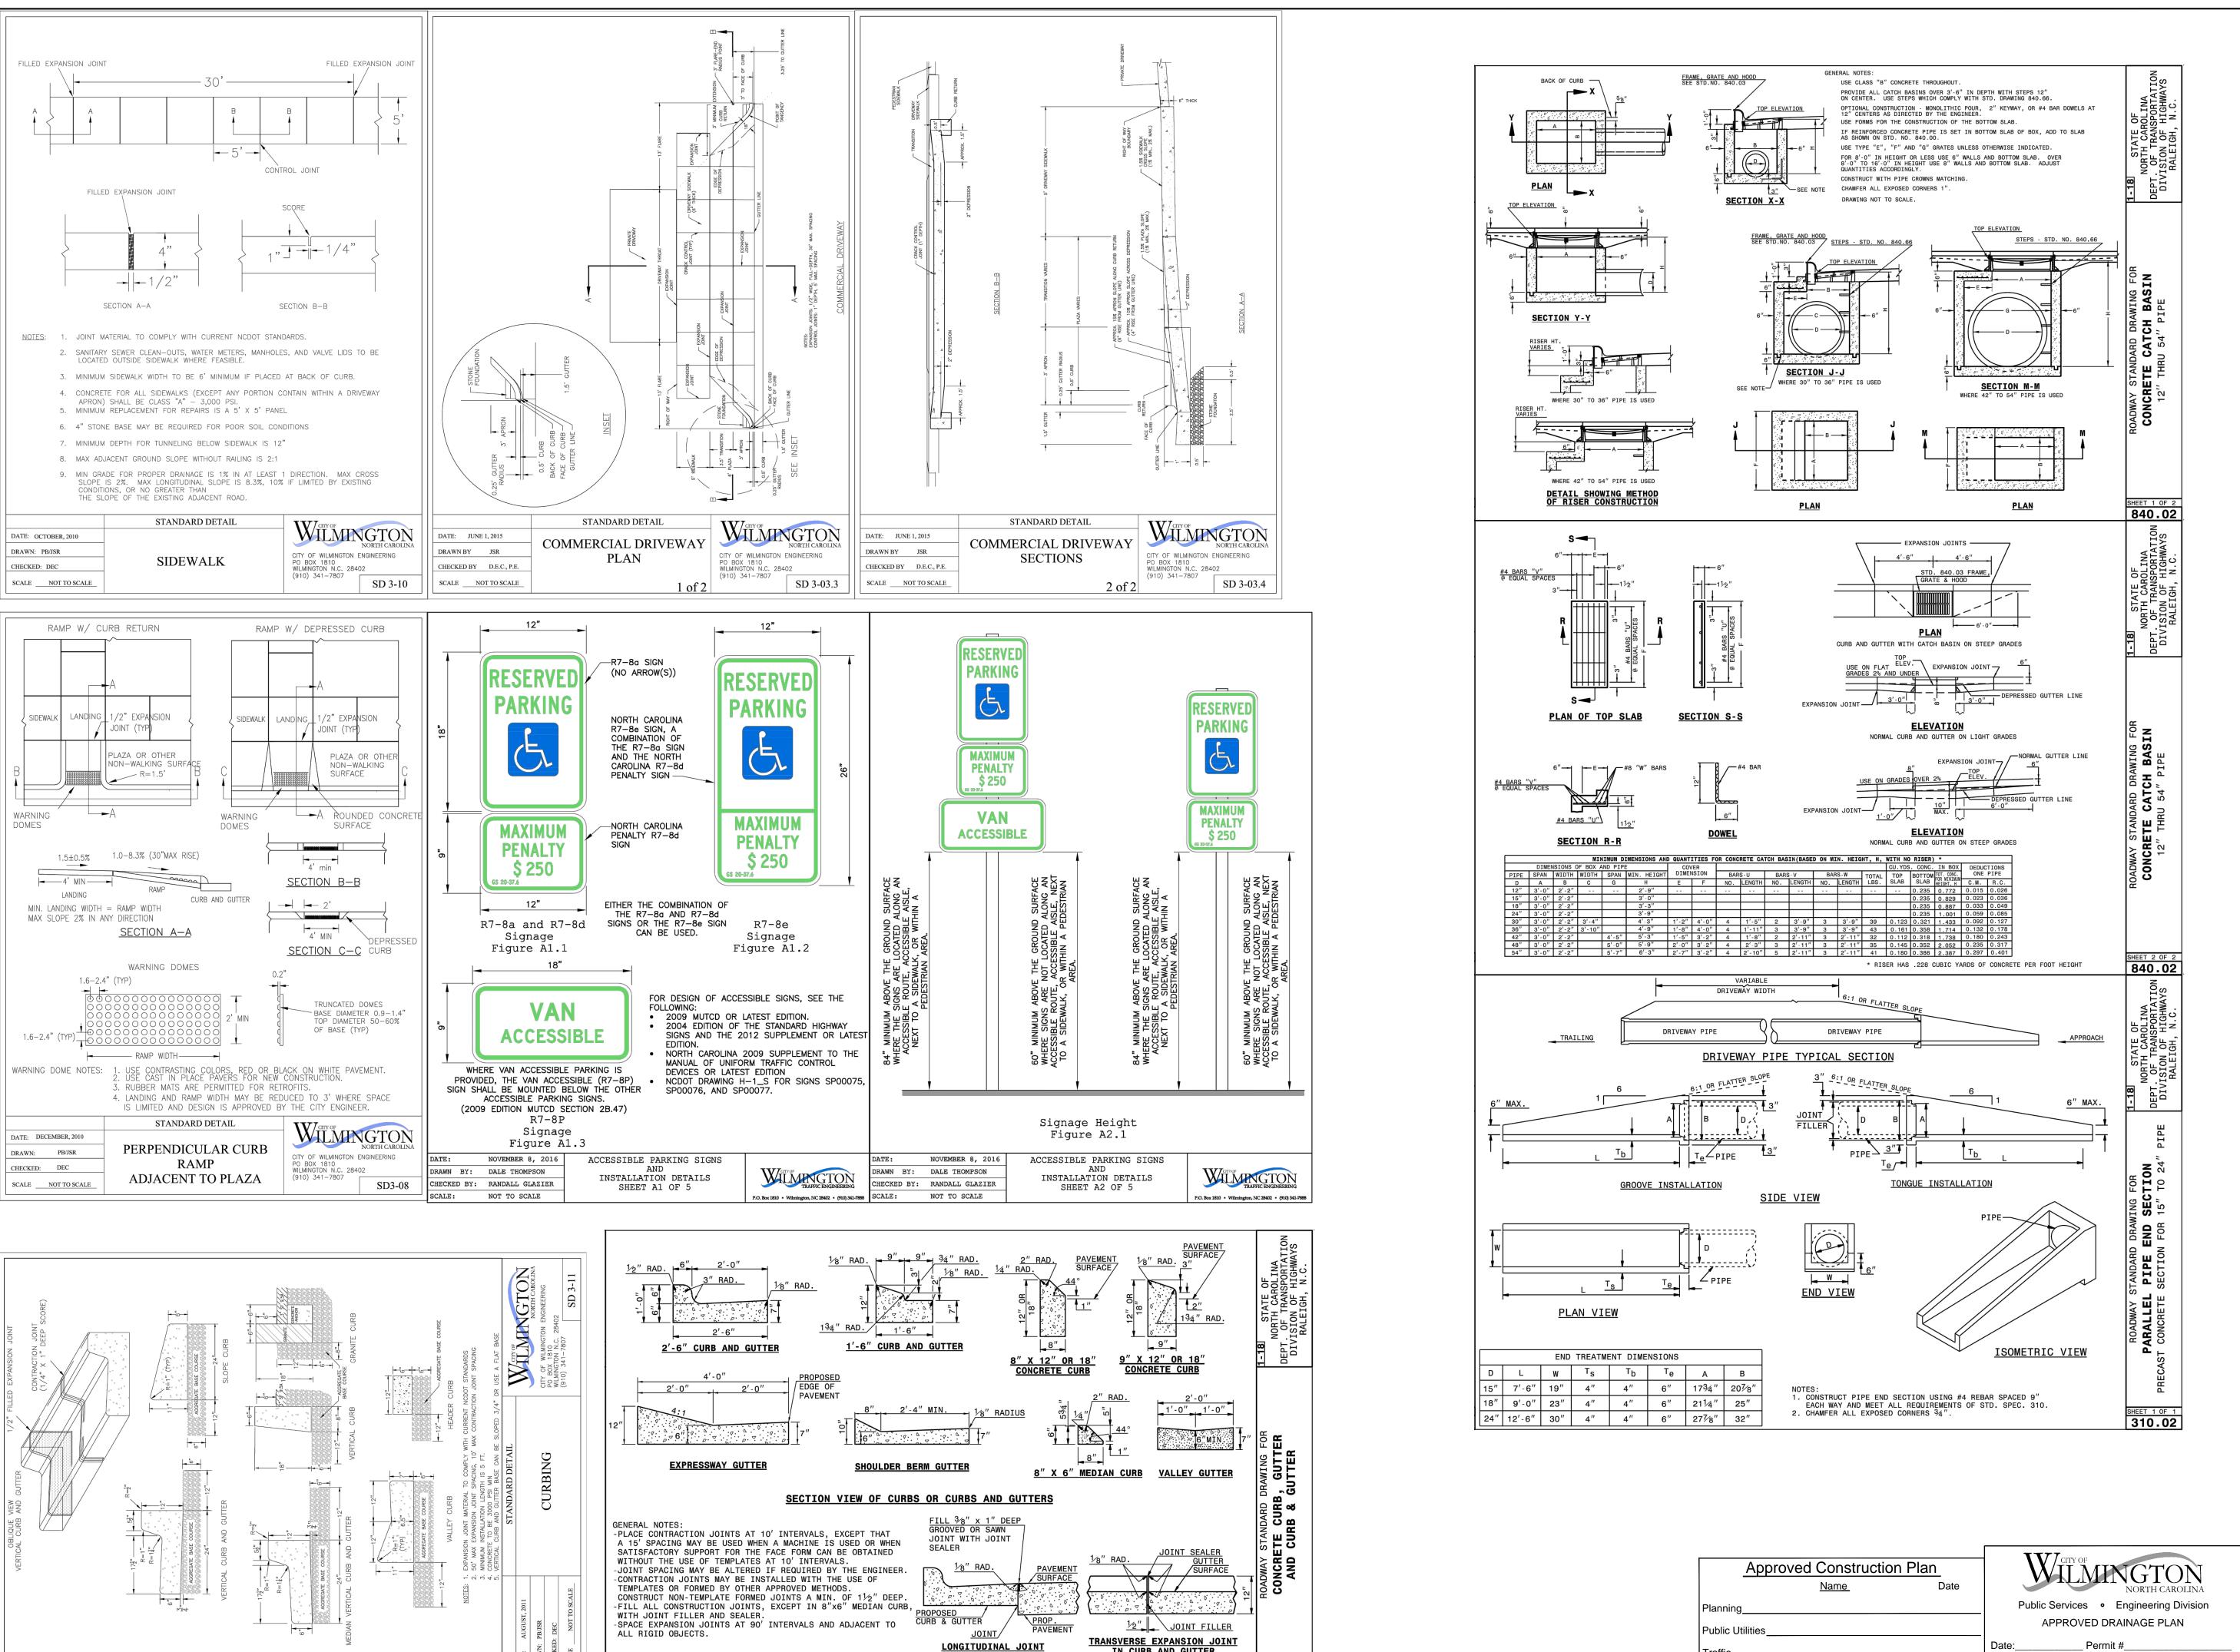

IN CURB AND GUTTER

SECTION VIEW OF JOINTS

SHEET 1 OF 3 846.01

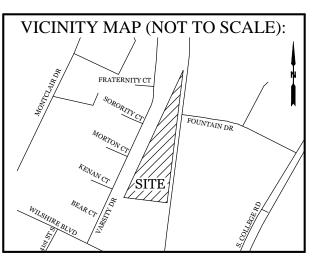


REVISIONS



DETAIL

MBLY SE S KERR

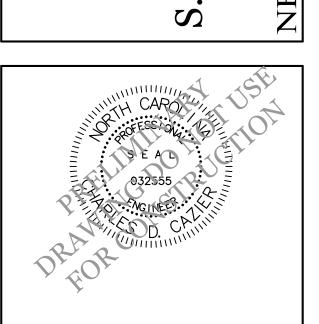


CLIENT INFORMATION: Wilmington Brewing Company, LLC 824 S. Kerr Ave. Wilmington, NC 28403 Ph. 910-392-3315

Ι,	ř			
	DRAWN:	JAE	SHEET SIZE:	24x36
	CHECKED:	CDC	DATE:	8/16/2019
	APPROVED:	CDC	SCALE:	NTS
	PROJECT NUMBI	ER:	2018-035	

DRAWING NUMBER:

Signed:

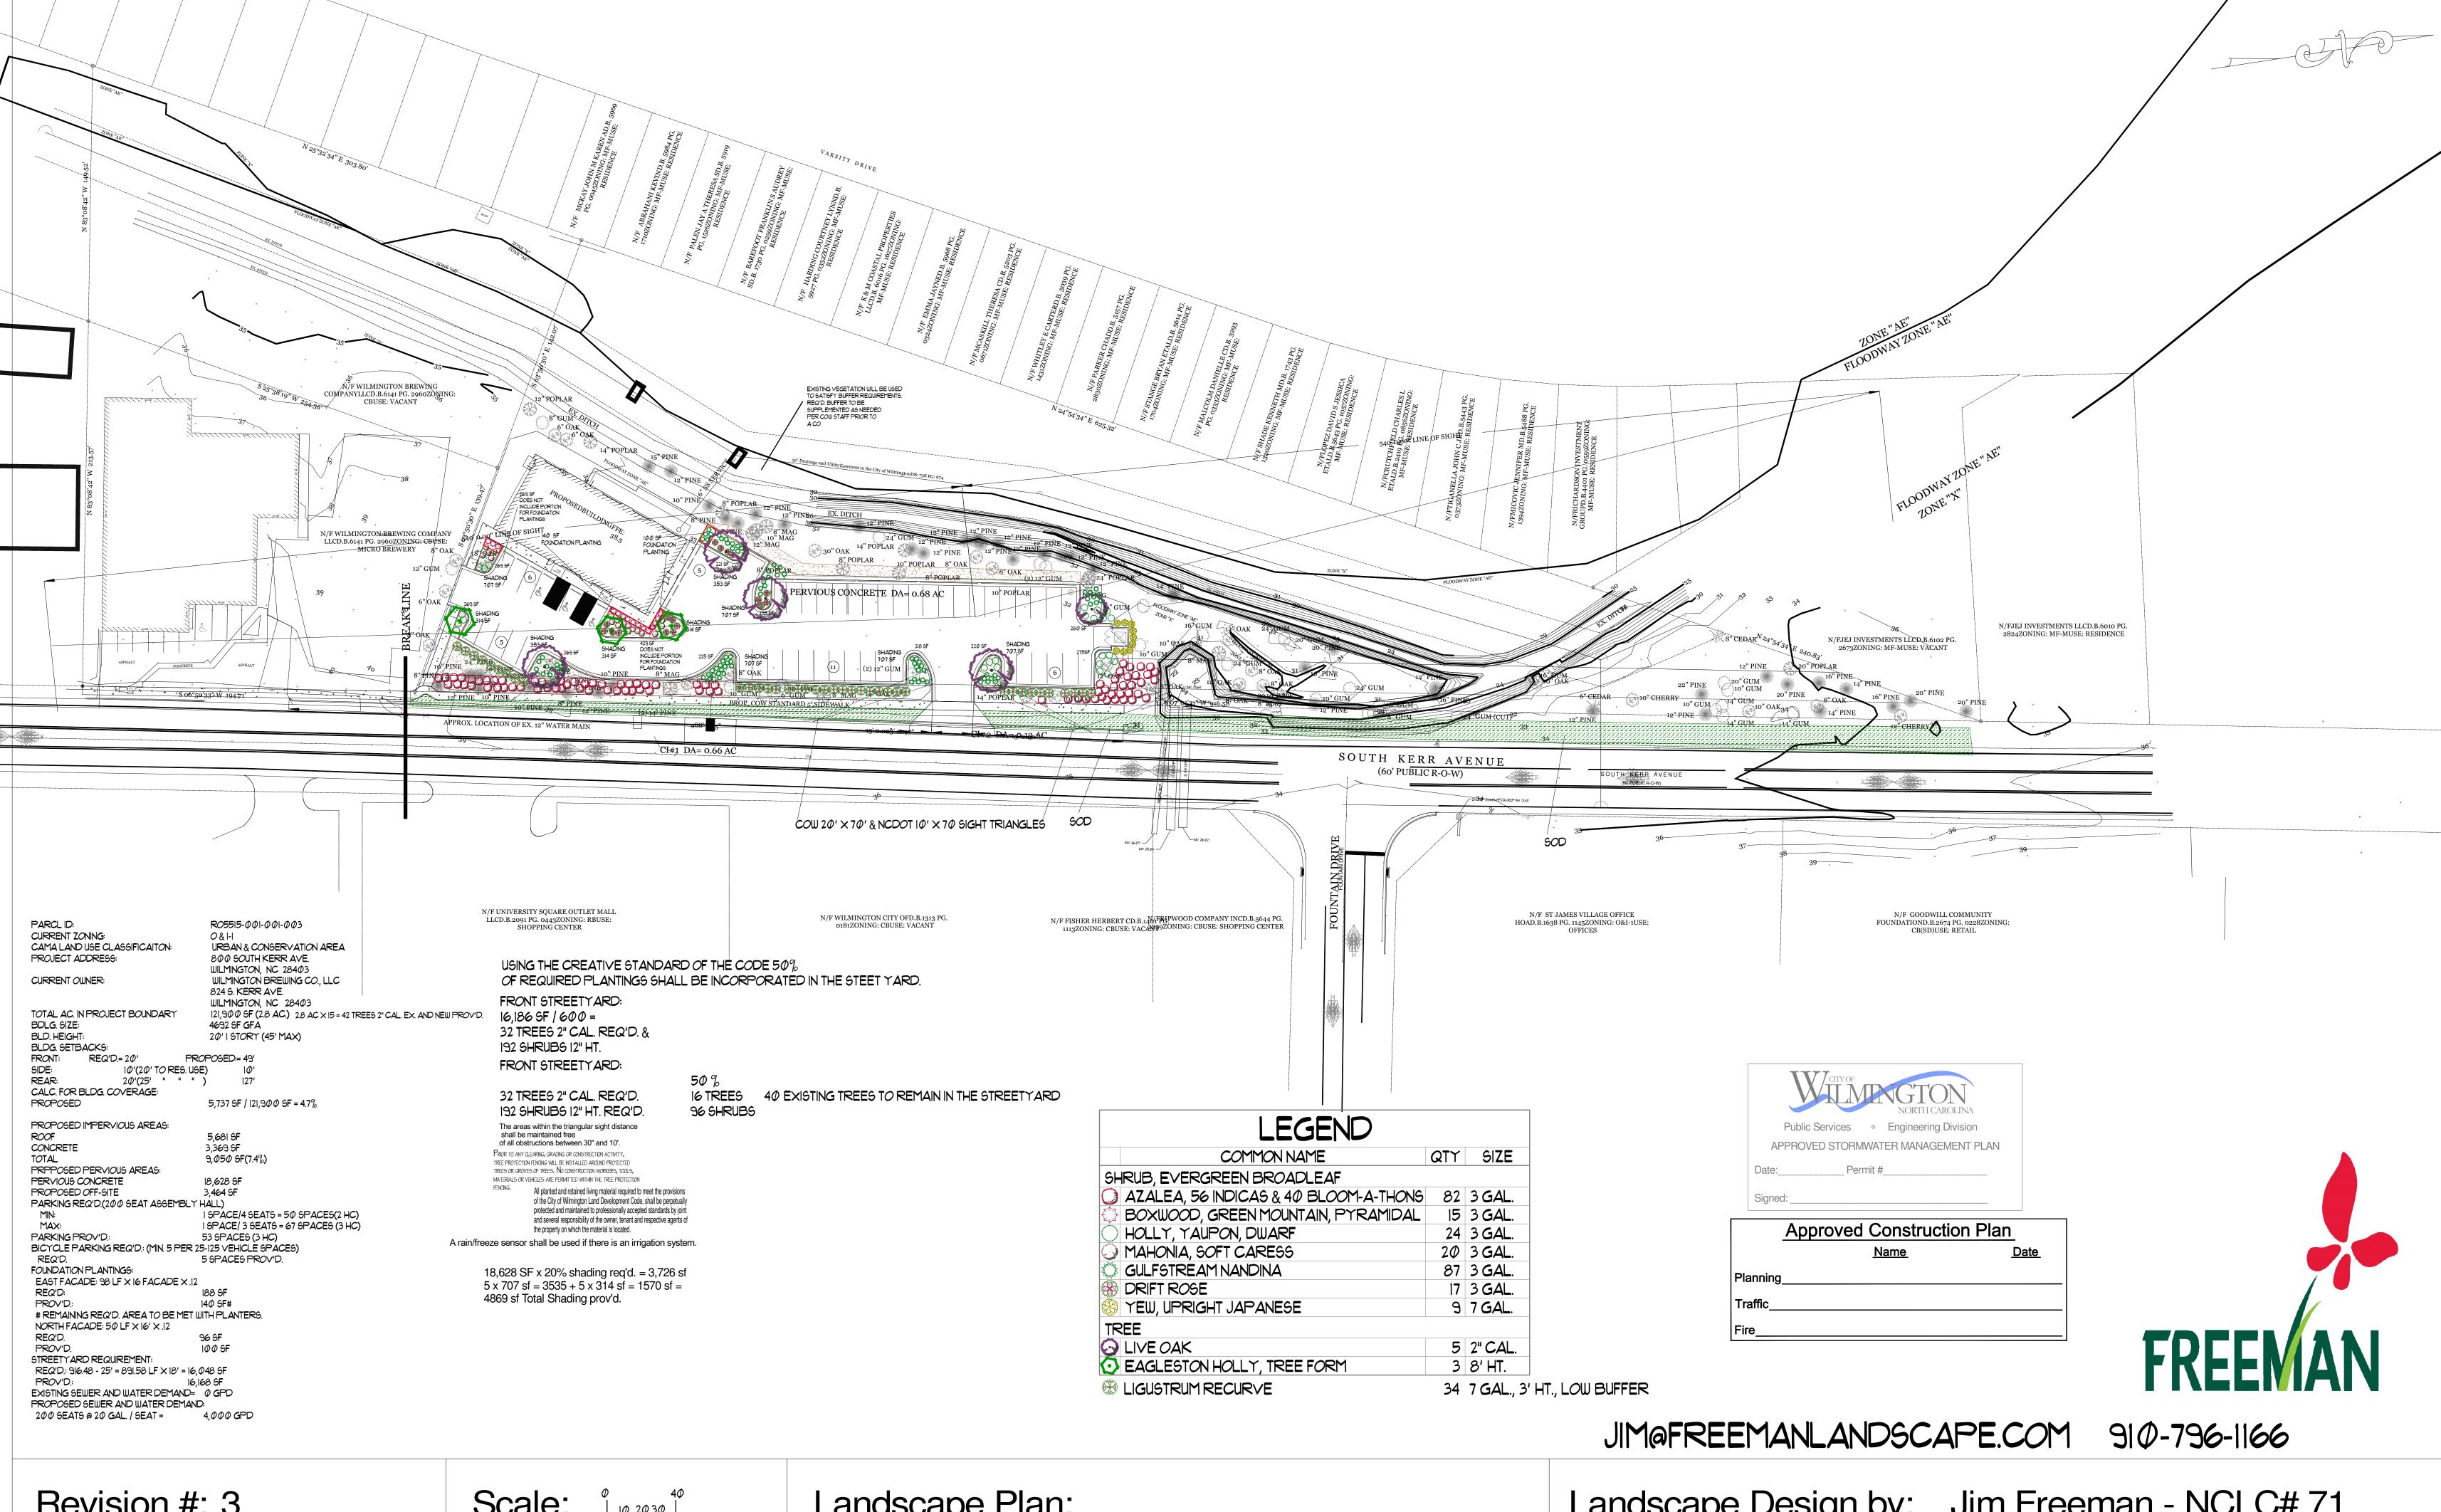

Revision #: 3

Date: 8/14/2019

Scale:


1" = 40'

Landscape Plan:


S. Kerr Assembly Hall

Landscape Design by: Jim Freeman - NCLC# 71

Freeman Landscape, Inc.

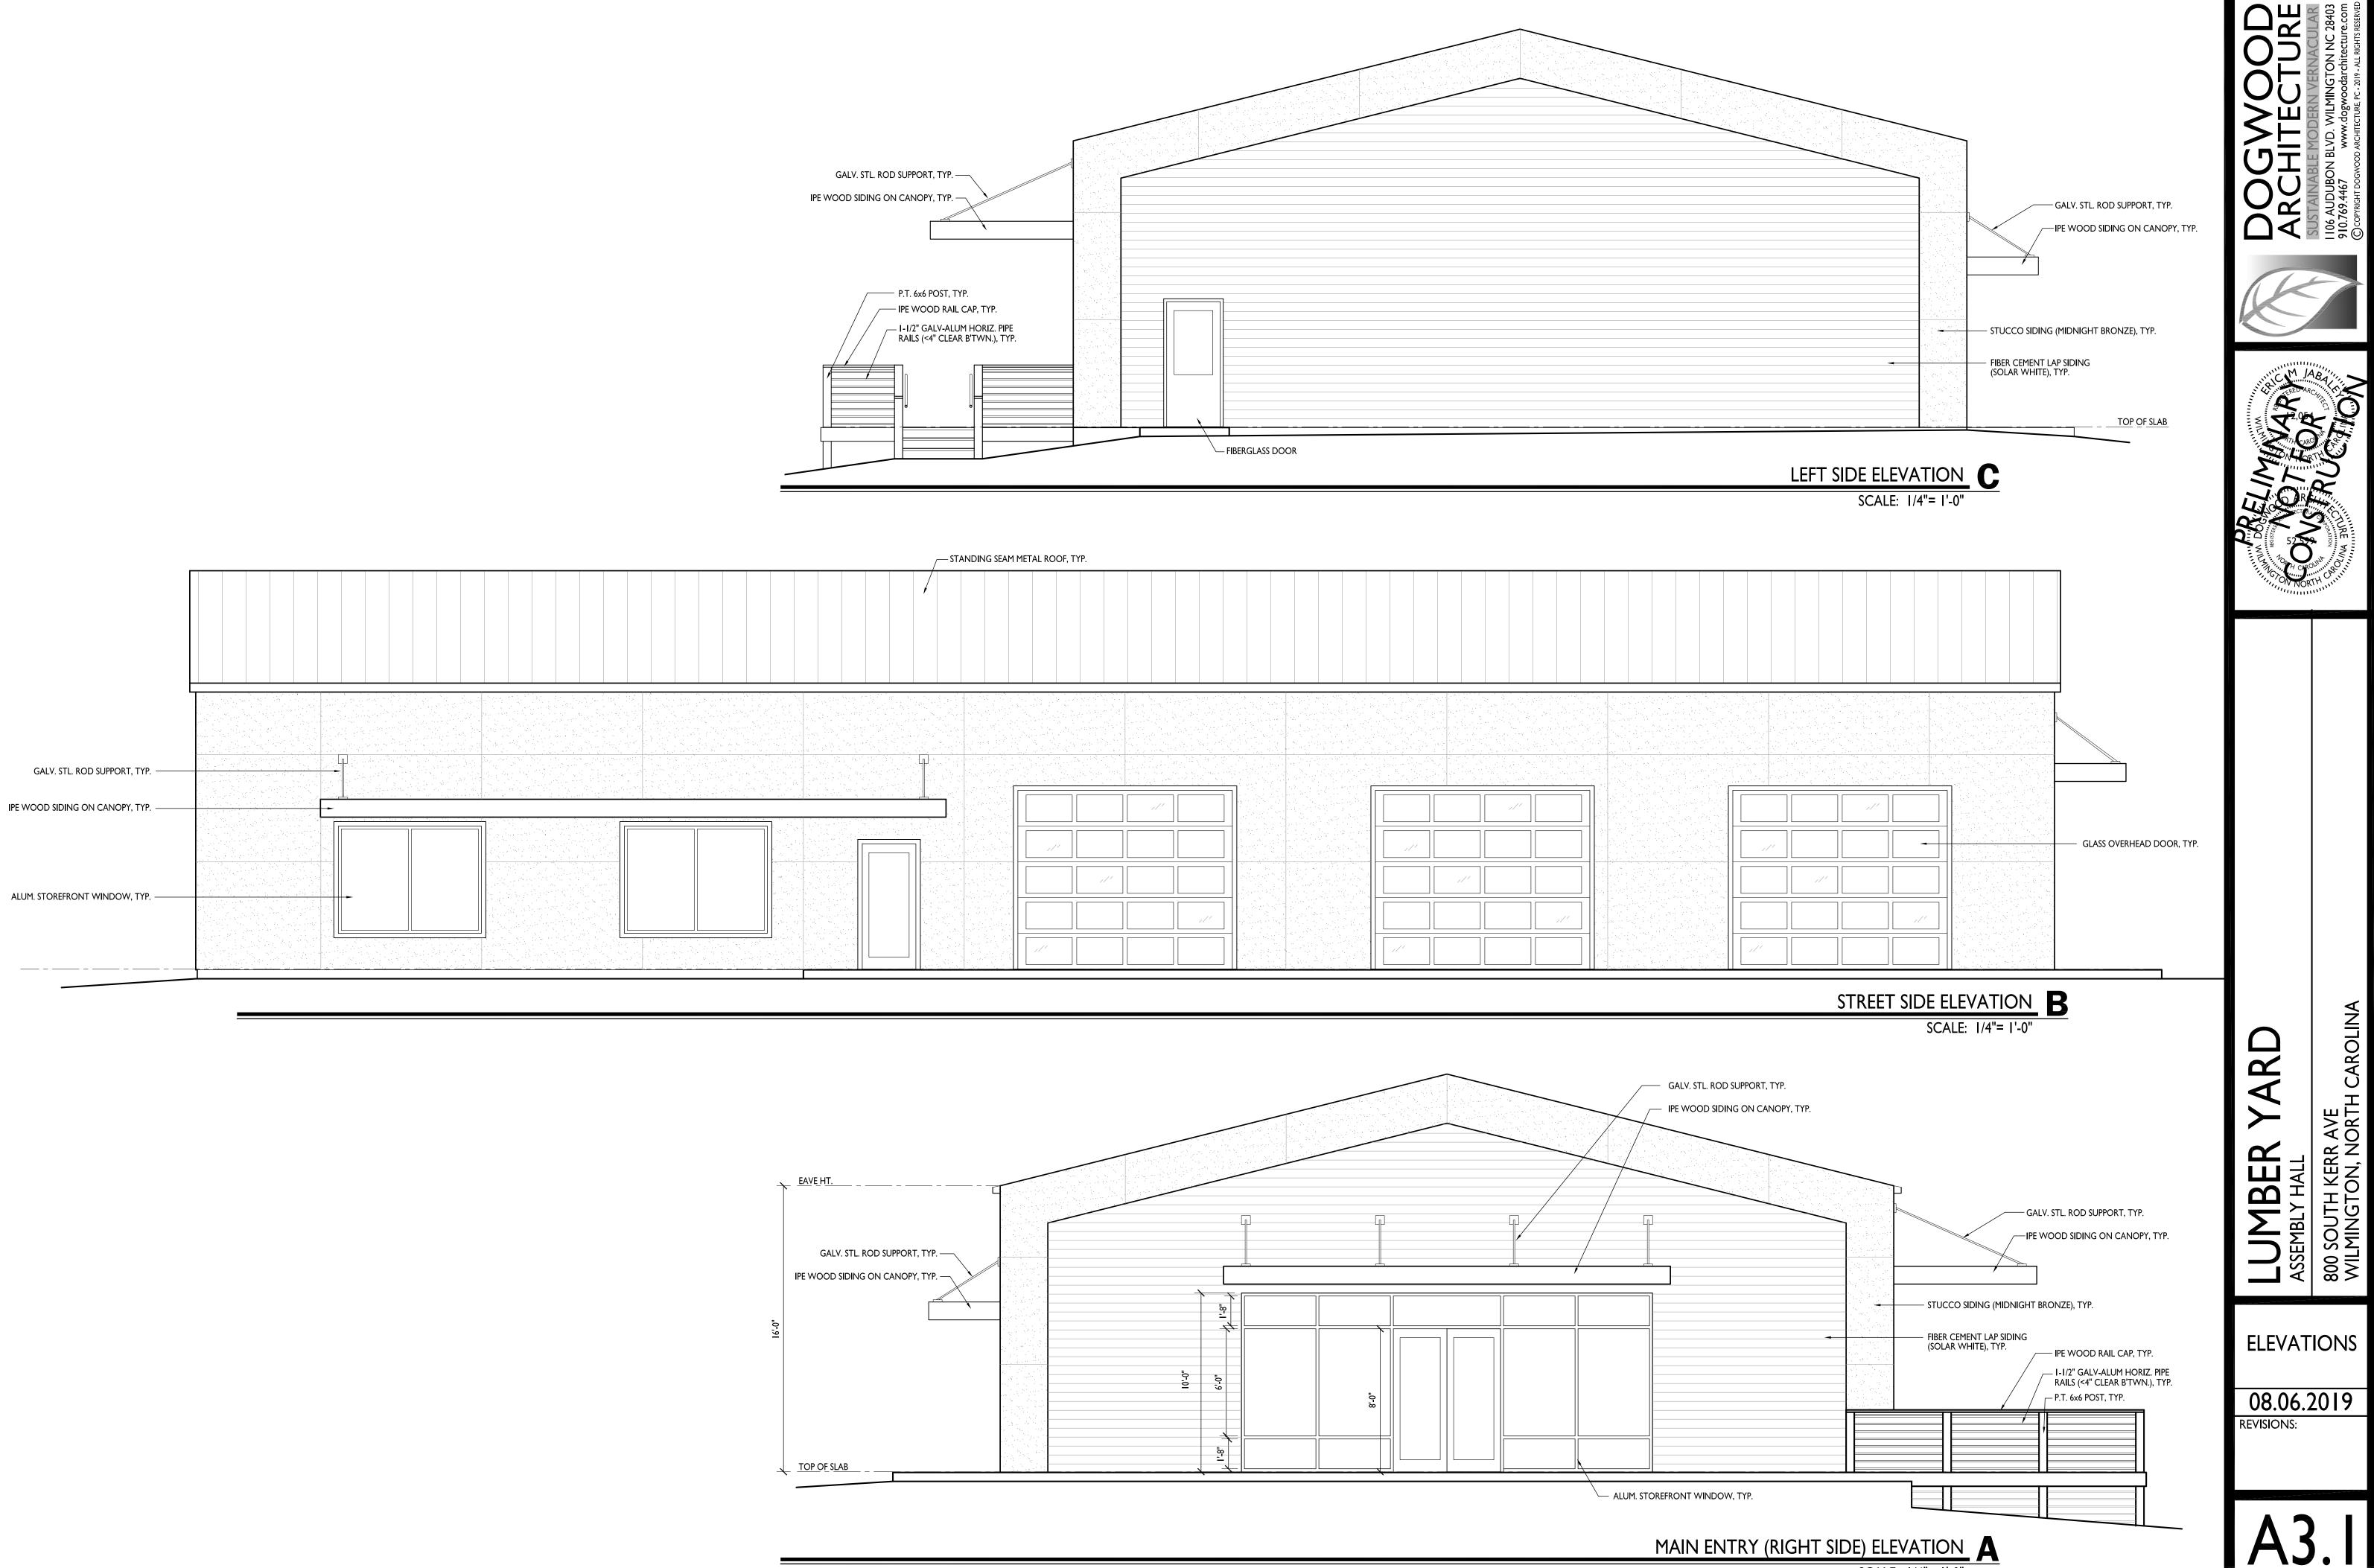



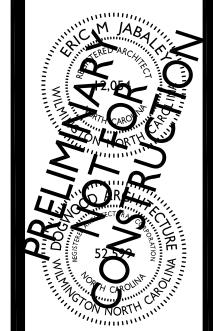

ELEVATIONS

08.06.2019

SCALE: 1/4"= 1'-0"